CHS.ATM.155


## **Remote ATM Program**

## SOMERVILLE SULLIVAN SQUARE

6 Broadway Somerville, MA 02145




02.05.19 ZAS Added E03.02.08.19 MMS Revised as Noted.

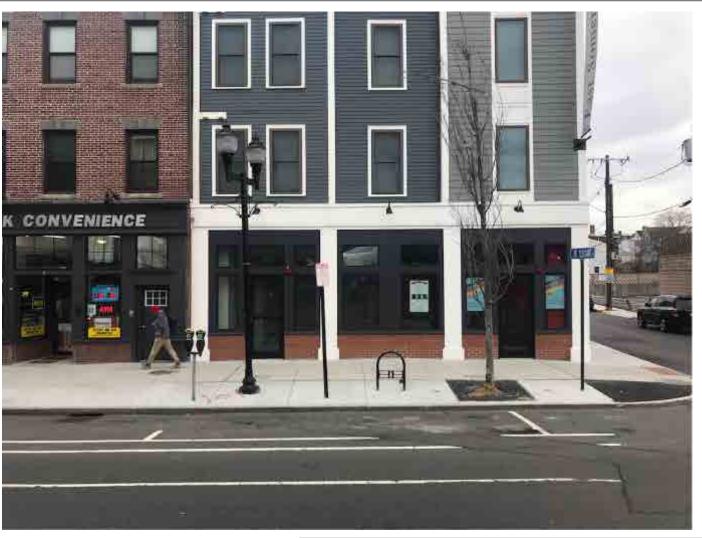





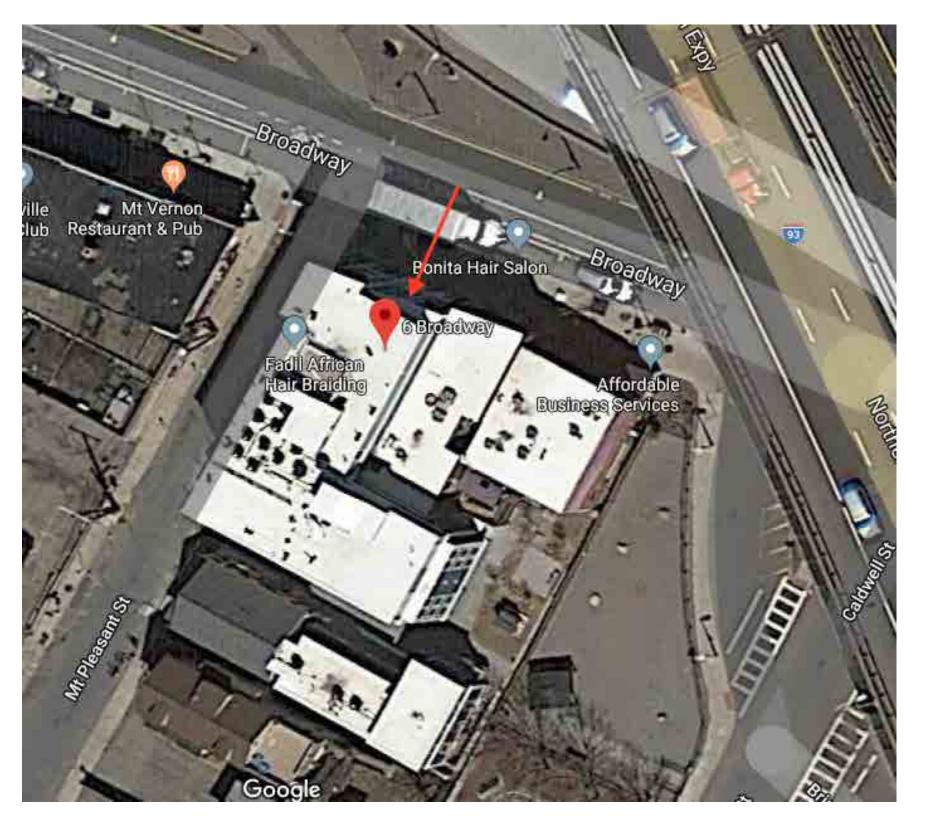




TITLE	New Market ATM	DWG BY ZAS	DATE	01/28/19	
ADDRESS	CHS.ATM.155 - Somerville Sullivan Sq	- Somerville Sullivan Square		B81852	
	6 Broadway Somerville, MA 02145		SHEET	2	

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### Site Plan



Sc	ope of Work		
01	LNIC-BLK-ATM-10	Non-Illuminated Black w/ Blue Oct Dimensional Letters	<b>8.7</b> sf
03	AWN-M-D	Non-Illuminated Metal Awning - Without Descriptor	TBD

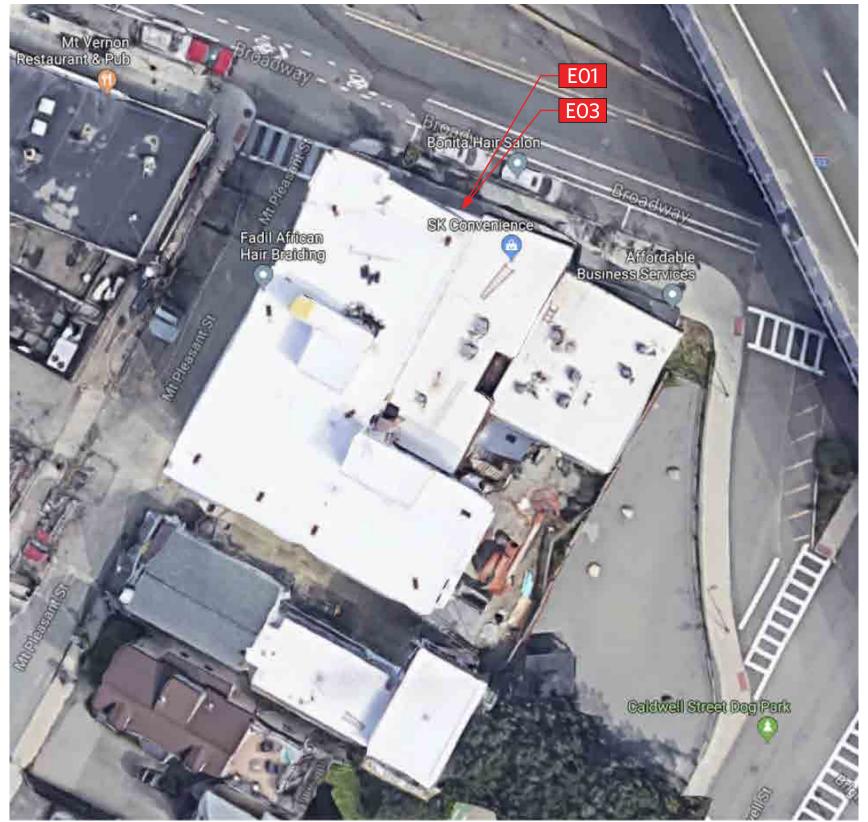







TITLE	New Market ATM	DWG BY ZAS	DATE	01/28/19
ADDRESS	Ch3.ATM. 155 - Somerville Sullivan Square		DWG NUM	B81852
	6 Broadway Somerville, MA 02145		SHEET	3


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ADA-EP
HANDICAPPED ENTRANCE PLAQUE
SCALE: NTS


CUST-VIN

MATCHING BLUE VINYL BACKER

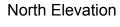SCALE: NTS

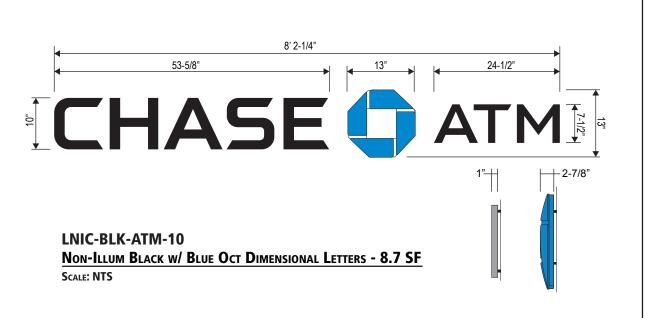

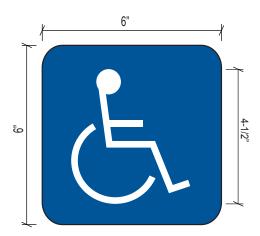SIGN E02 MOUNTS BACK-TO-BACK WITH 101.

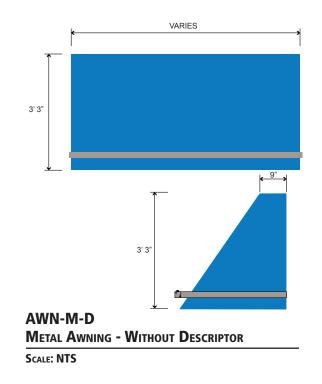



TITLE	New Market ATM	DWG BY ZAS	DATE	01/28/19
ADDRESS	CHS.ATM.155 - Somerville Sullivan Square		DWG NUM	B81852
	6 Broadway Somerville, MA 02145		SHEET	5

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## **Survey Photos**











































ITLE	New Market ATM	DWG BY ZAS	DATE	01/28/19
DDRESS	CHS.ATM.155 - Somerville Sullivan So	DWG NUM	B81852	
	6 Broadway Somerville, MA 02145		SHEET	8

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# Sheet Index

A-100 Floor Plan

A-200 Reflected Ceiling Plan

AE-1 Exterior Elevations

# Project # 1823-038

Project Address: 6 BROADWAY

SOMERVILLE, MA 02145

Site Code: N/A


On-Site Date: 12-13-2018

Project Square Footage: 498 SQFT

Client: CORE STATES

Owner: CHASE

# **Additional Documents**

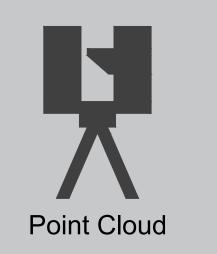









(CLICK TO OPEN)

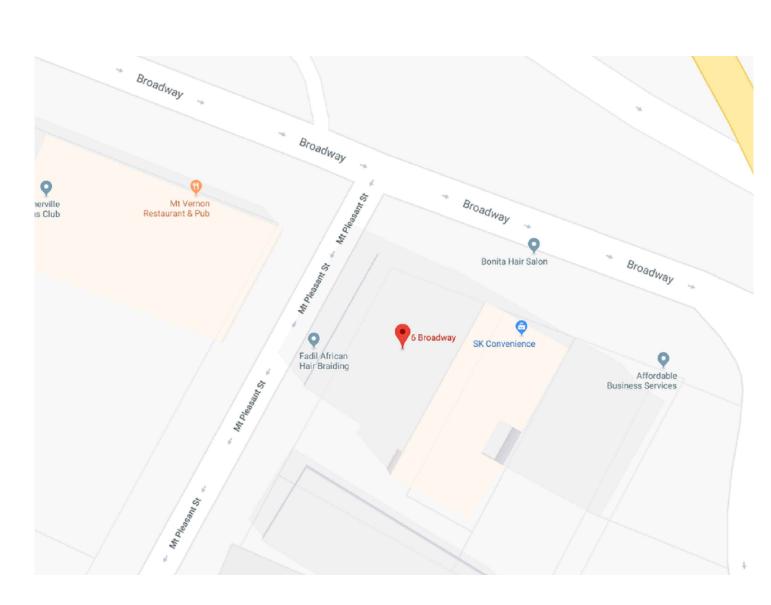

Site Map




**Existing Site Photo** 

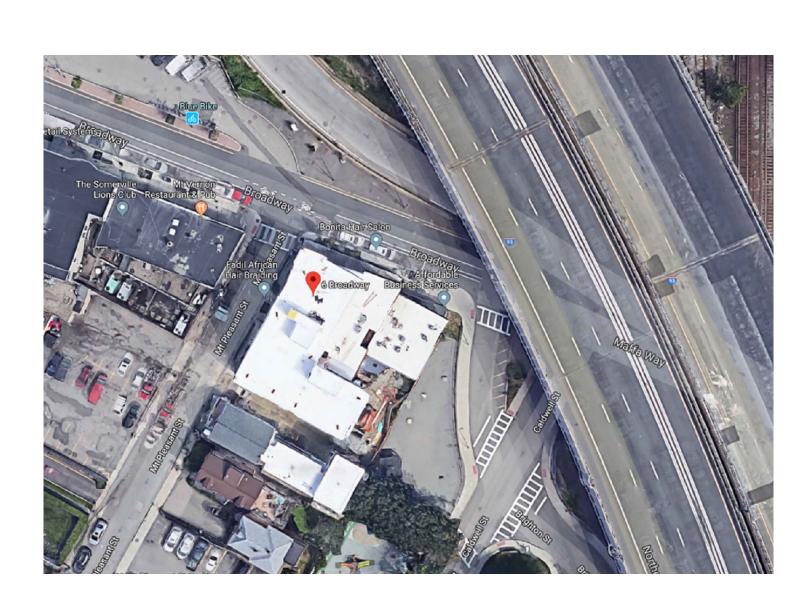

Site Aerial



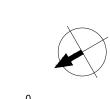

3/8" = 1'-0"

6 COUNTER 1 MAIN ENTRANCE 7 FLOOR DRAIN **EMERGENCY EXIT** SERVICE ENTRANCE ADA STALL 9 FLOOR TRANSITION LOW WALL 10 PATIO / DECK 5 FIRE EXTINGUISHER

**DETAIL TAG** A500 1 INTERIOR ELEVATION TAG

RM NM. ROOM NAME T-LIN FLOOR FINISH CEILING HEIGHT 9'-8" 1.01 DOOR TAG

WINDOW TAG

 $\langle 1.A \rangle$ 

**EXIT** EXIT SIGN G.M. UTILITY METER ELEC ELECTRIC PANEL FIRE PANEL

SECURITY PANEL

THERMOSTAT PULL STATION STROBE LIGHT KEY PAD

MOTION SENSOR

DUPLEX OUTLET DOUBLE DUPLEX FLOOR OUTLET DATA PORT

FLOOR DATA

LIGHT SWITCH CO

CLEAN OUT FLOOR DRAIN FIRE EXTINGUISHER

• SLOPE + 0.0 % ► RAMP SLOPE

360 BUBBLE

PHOTO BUBBLE

A-100 PAGE DETAIL: FLOORPLAN

PAGE NUMBER:

SIZE: 22" X 34"

IN THE PDF VERSION OF THIS DRAWING YOU MAY CLICK ON THESE SYMBOLS AND THE 360 DEGREE IMAGE, OR HD PHOTO WILL OPEN THROUGH YOUR WEB BROWSER

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ADA COMPLIANCE
 SITE INVESTIGATION

BOMA CALCULATION
 BIM MODELING





SITE ADDRESS:

6 BROADWAY SOMERVILLE, MA 02145

PROJECT NAME:

CHASE ATM - SOMERVILLE

PROGRAM NAME:


**CHASE NEW ATM** 

DISCLAIMER THESE DRAWINGS ARE A REPRESENTATION OF THE EXISTING PHYSICAL CONDITIONS FOR THE ADDRESSED PROPERTY ABOVE AND SHALL NOT BE USED FOR ANY OTHER REASON.

ON-SITE DATE	12-13-2018
DELIVERY DATE	12-17-2018
SURVEYOR	110
DRAFTER	111
REVIEWED BY	101
SITE CODE	N/A
CLIENT JOB#	N/A
DE JOB#	1823-038
FILE NAME	1823-038_DRAWING

SCALE: NOTED

04

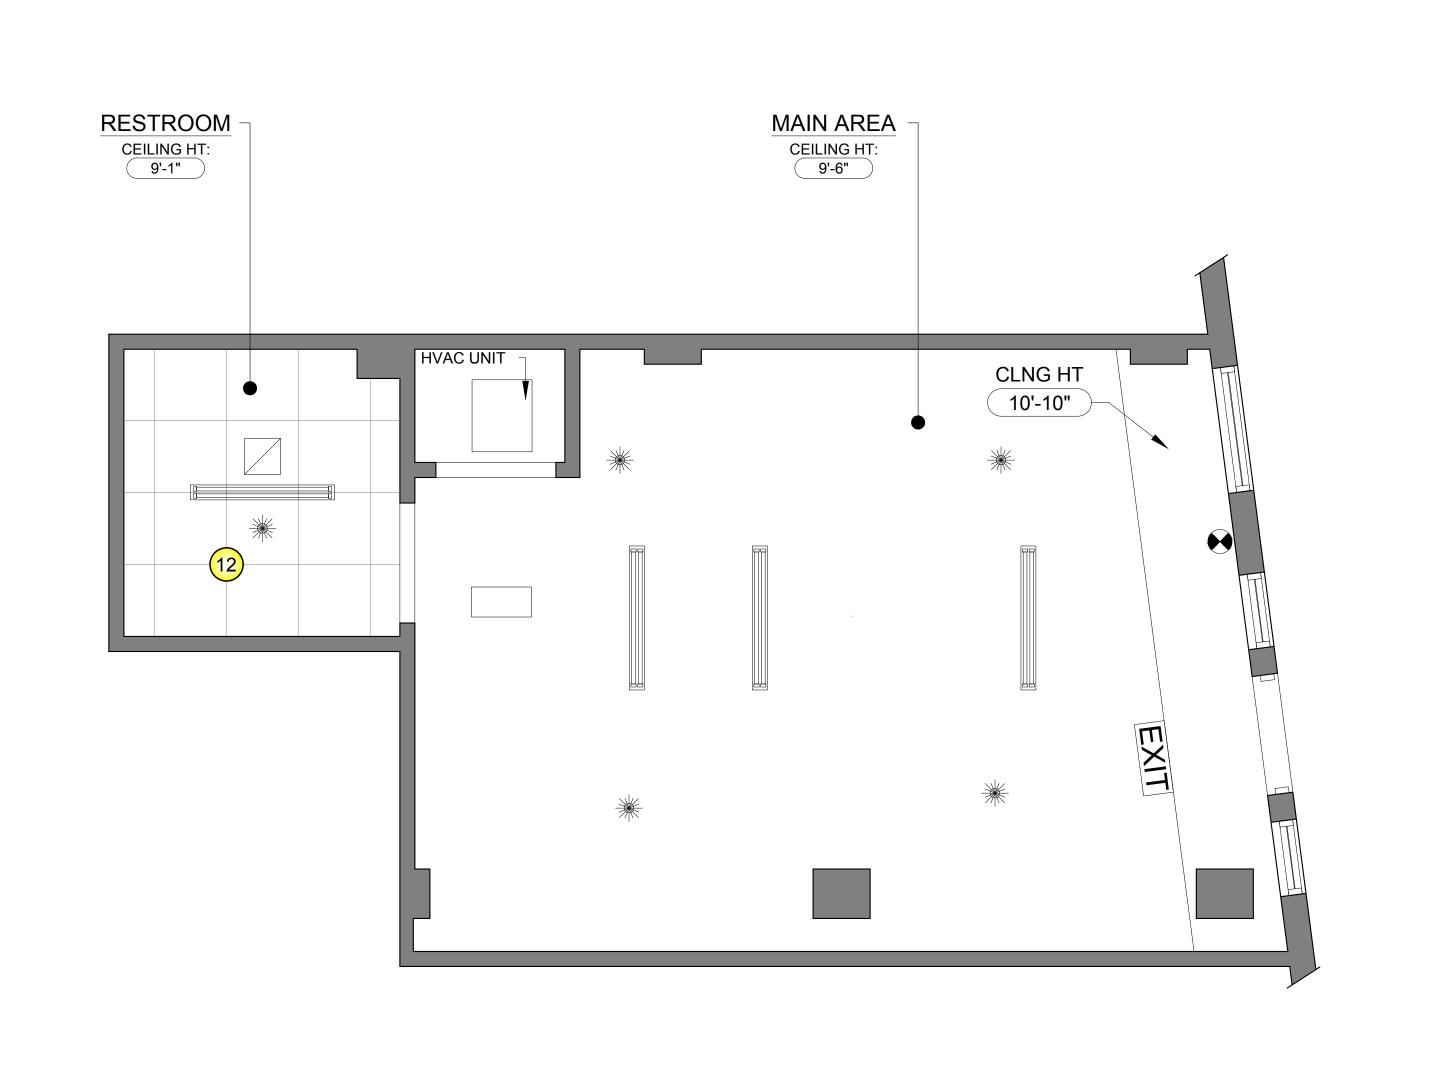



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ADA COMPLIANCE
 SITE INVESTIGATION

BOMA CALCULATION
 BIM MODELING

OLIENT



OWNER:



SITE ADDRESS:

6 BROADWAY SOMERVILLE, MA 02145

PROJECT NAME:

CHASE ATM - SOMERVILLE

PROGRAM NAME:


**CHASE NEW ATM** 

\_\_\_

DISCLAIMER

THESE DRAWINGS ARE A REPRESENTATION OF THE EXISTING PHYSICAL CONDITIONS FOR THE ADDRESSED PROPERTY ABOVE AND SHALL NOT BE USED FOR ANY OTHER REASON.

ON-SITE DATE	12-13-2018
DELIVERY DATE	12-17-2018
SURVEYOR	110
DRAFTER	111
REVIEWED BY	101
SITE CODE	N/A
CLIENT JOB#	N/A
DE JOB#	1823-038
FILE NAME	1823-038_DRAWING

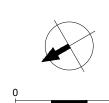

3/8" = 1'-0

									0,0 , 0
1 SOFFIT	RM NM. ROOM NAME	2FT X 4FT FLORESCENT	SUSPENDED LIGHT FIXTURE	RECESSED LIGHT	CEILING ELECTRICAL OUTLET	T 🛞 SPEAKER	2FT X 2FT HVAC SUPPLY	SIDE DISCHARGE	FAN
2 BEAM	CLNG HT 9'-8" HEIGHT CALL OUT		TRACK LIGHT	RECESSED DIRECTIONAL	● EMERGENCY LIGHT	SECURITY CAMERA		<b>* *</b>	
3 DUCT		1FT X 4FT FLORESCENT		RECESSED PIN LIGHT	EMERGENCY LIGHT W/ DIR.	SECURITY BUBBLE	2FT X 2FT HVAC RETURN	SIDE RETURN	EXHAUST FAN
4 TRUSS	A LIGHT FIXTURE TAG		LIGHT SURFACE MOUNTED	WALL MOUNTED SCONES	EXIT EXIT SIGN	SD SMOKE DETECTOR		) (	
5 PIPING	1 RTU EQUIPMENT TAG	2FT X 2FT FLORESCENT	⊗□ SURFACE DIRECTIONAL	PENDANT LIGHT	EXIT SIGN W/ EMG LIGHT	** SPRINKLER HEAD	2FT X 2FT SUPPLY	FIXED LADDER	CEILING ACCESS


PAGE: 03 OF: 04

PAGE NUMBER: A-200

PAGE DETAIL:

REFLECTED CEILING

PLAN

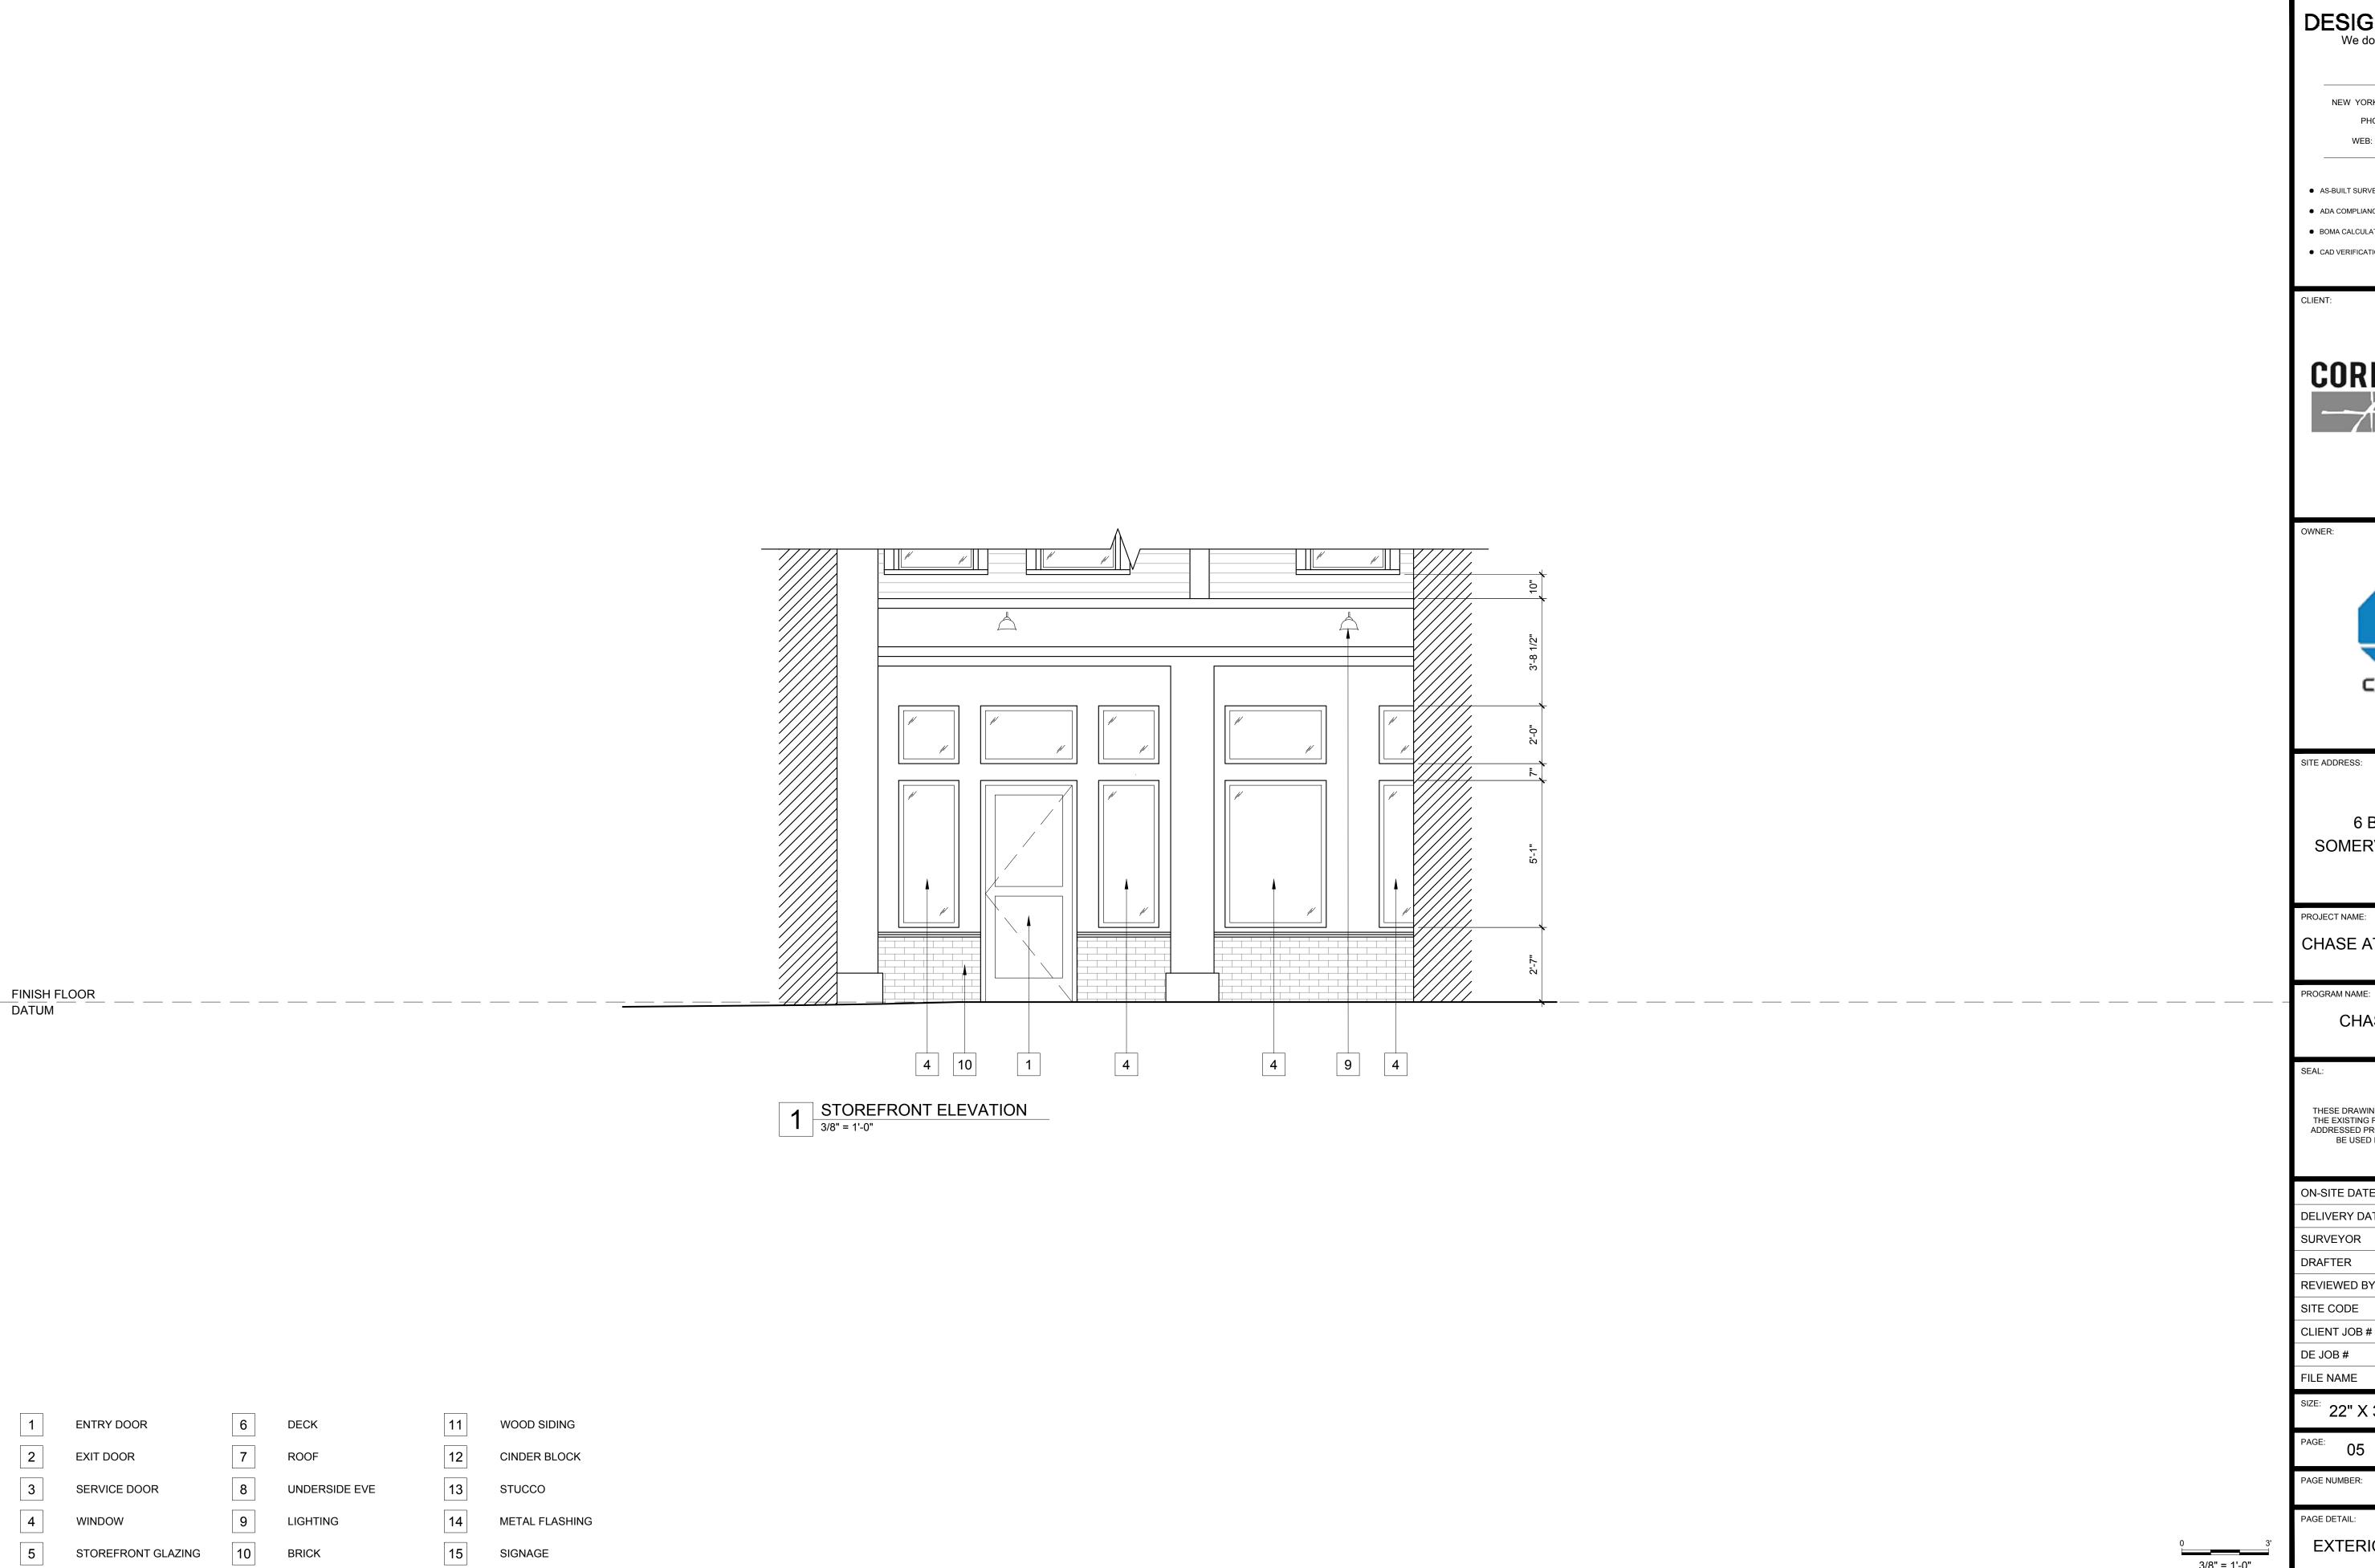

10

BRICK

SIGNAGE

STOREFRONT GLAZING

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■ BOMA CALCULATION
 ■ BIM MODELING

• CAD VERIFICATION • 360 DEGREE PHOTOS





6 BROADWAY SOMERVILLE, MA 02145

PROJECT NAME:

CHASE ATM - SOMERVILLE

**CHASE NEW ATM** 

**DISCLAIMER** THESE DRAWINGS ARE A REPRESENTATION OF THE EXISTING PHYSICAL CONDITIONS FOR THE ADDRESSED PROPERTY ABOVE AND SHALL NOT BE USED FOR ANY OTHER REASON.


12-13-2018
12-17-2018
110
111
101
N/A
N/A
1823-038
1823-038_DRAWING

22" X 34"	SCALE:	NOTED
. 05	OF:	04

AE-01

3/8" = 1'-0"

**EXTERIOR ELEVATIONS** 

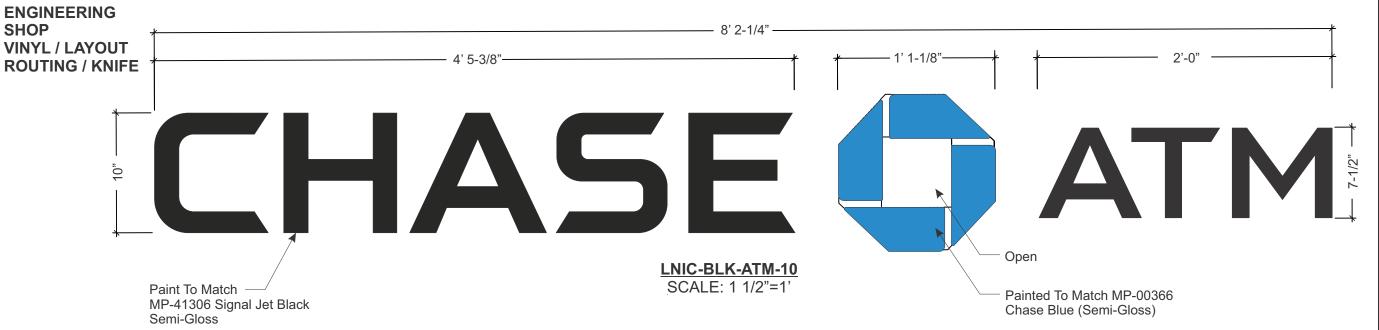


#### General Notes:

- 1. Design is based on a 115 mph, 3 second gust wind design per IBC 2015 (ASCE 7-10). Category II, Exposure C. Components and Cladding Zone 5.
- 2. No additional wind catching surfaces are added to the building structure. The customer's building engineer is to determine the adequacy of the supporting structure.
- 3. Extruded aluminum shapes shall be 6061-T6 alloy. Aluminum sheet shall be 3003-H14 alloy. Aluminum plate shall be 5052-H34 alloy.
- 4. All welds shall be made using 5356 filler for aluminum by persons qualified in accordance with AWS standards within the past two years.
- 5. All fasteners shall be stainless steel or zinc coated to prevent corrosion.
- 6. All wall penetrations shall be sealed to prevent water penetration.
- 7. J.P. Morgan Chase will not be responsible for the safety on this job site before, during or after installation of this structure. It is the responsibility of the contractors and installers to ensure that the installation and erection of this structure is performed using methods that are in full compliance with OSHA regulations.
- 8. Any deviation from this design or from any part of this drawing, including the General Notes, without prior written consent from J.P. Morgan Chase voids this drawing in its entirety.
- 9. The structure designed on this drawing is prototypical and should not be used for site specific applications unless deemed suitable by a Competent Professional Engineer.

Note: This sign is intended to be installed in accordance with the requirements of Article 600 of the National Electrical Code and/or other applicable local codes. This includes proper grounding and bonding of the sign.



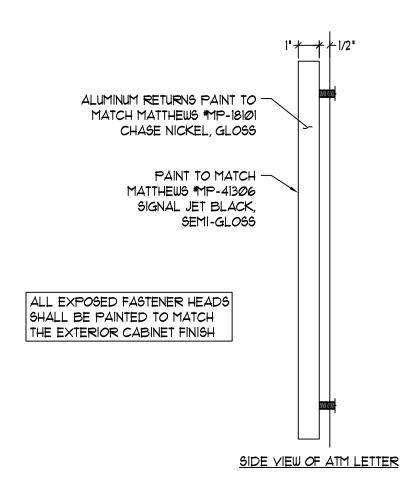



707 West Spring Garden Street Palmyra, New Jersey 08065

Phone: 856.829.1460 Fax: 856.829.8549 www.philadelphiasign.com

**CUSTOMER:** 

Chase

JOB NUMBER:

**Chase ATM Program** 

**SIGN TYPE:** 

LNIC-BLK-ATM-10/12/14/16/18/220/24

LOCATION:

10717 CAMINO RUIZ SAN DIEGO, CA

DATE:

4/5/2019

DRAWN BY:

AVA

REVISION:

Number: Date:

By:

ENG DEPT


SHEET:

1 OF 1

DWG NUMBER:

B-82839

**ENGINEER SEAL:** 

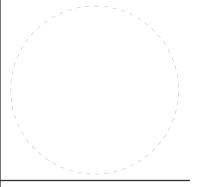

MAX DESIGN WIND SPEED 90 MPH EXPOSURE C


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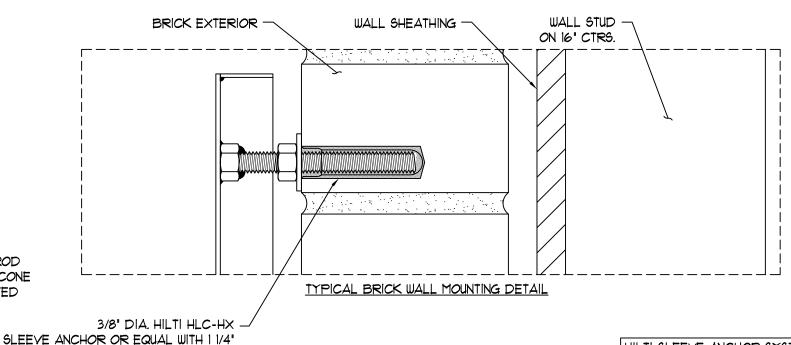
### ENGINEERING SHOP VINYL / LAYOUT ROUTING / KNIFE

.063" ALUM. RETURNS WELDED TO FACE PAINT TO MATCH MATTHEWS #MP-18101 CHASE NICKLE, GLOSS PAINT TO MATCH -MATTHEWS #MP-41306 SIGNAL JET BLACK, SEMI-GLOSS 3/8-16 ALUMINUM NUT (WELD TO INSIDE OF FACE)

NOTE:

PIPE SPACER MAY BEAR ON WALL SHEATHING ONLY IF THE SHEATHING IS 1/2" THICK PLYWOOD OR GREATER IF THE WALL SHEATHING IS PLYWOOD THAT IS LESS THAN 1/2" THICK OR IS ANYTHING OTHER THAN PLYWOOD, THE PIPE SPACER SHALL BE EXTENDED TO BEAR ON THE WOOD BLOCKING BEHIND.



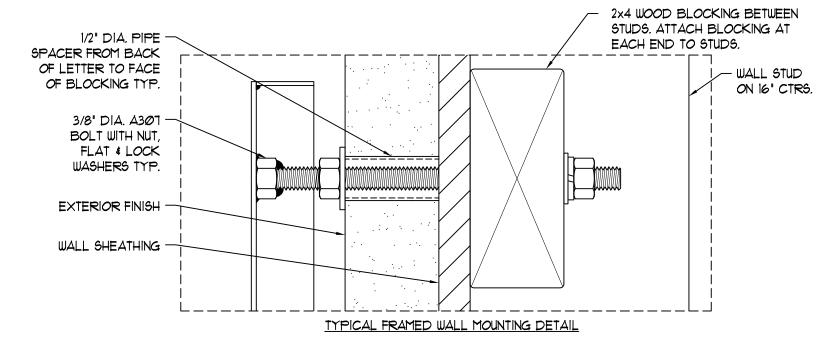

Note: This sign is intended to be installed in accordance with the requirements of Article 600 of the National Electrical Code and/or other applicable local codes. This includes proper grounding and bonding of the sign.

TYPICAL SECTION THROUGH LETTERS

3/8" DIA. THREADED ROD TO BE DIPPED IN SILICONE

BEFORE BEING INSERTED

MINIMUM EMBEDMENT TYP.

INTO NUT

HILTI SLEEVE ANCHOR SYSTEM OR
EQUAL SHALL BE INSTALLED IN STRICT
ACCORDANCE WITH THE MANUFACTURER'S
SPECIFICATIONS & RECOMMENDATIONS



707 West Spring Garden Street Palmyra, New Jersey 08065

Phone: 856.829.1460
Fax: 856.829.8549
www.philadelphiasign.com

**CUSTOMER:** 

Chase

JOB NUMBER:

Chase ATM Program

**SIGN TYPE:** 

LNIC-BLK-ATM-10/12/14/16/18/220/24

LOCATION:

10717 CAMINO RUIZ SAN DIEGO, CA

DATE:

4/5/2019

DRAWN BY:

**AVA** 

REVISION:

SHEET:

Number: Date:

By:

**ENG DEPT** 


2 OF 1

2 0 1

DWG NUMBER:


B-82839

**ENGINEER SEAL:** 

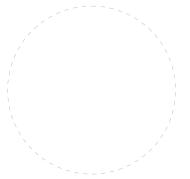

MAX DESIGN WIND SPEED 90 MPH EXPOSURE C

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ALL EXPOSED PAINTED SURFACES SHALL BE COATED WITH MATTHEWS #282-2085P VOC GLOSS CLEAR, WITH MINIMUM 2 MILS DRY FILM THICKNESS (DFT) PER MATTHEWS APPLICATION SPECIFICATIONS.
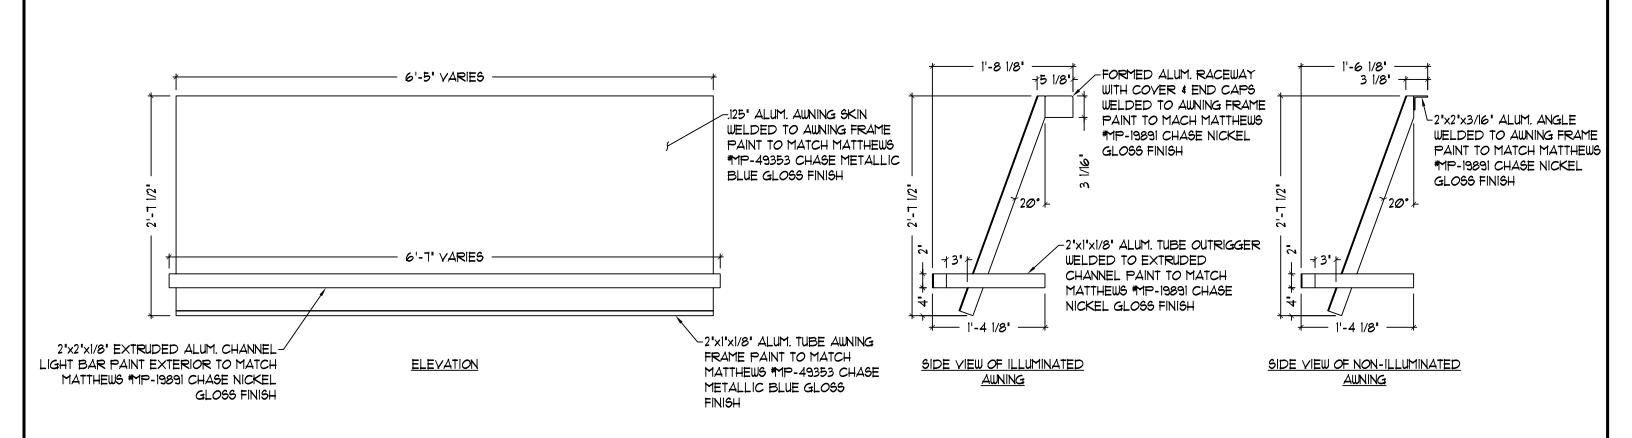
### NOTES:

- Design is based on 90 mph 3 sec gust design wind speed per IBC 2006. Exposure C.
- 2. Aluminum shapes shall be 6061-T6 alloy. Aluminum sheet shall be 3003-H14 alloy. Aluminum plate shall be 5052-H34 alloy.
- 3. All fasteners shall be stainless steel or otherwise coated to prevent corrosion.
- 4. All wall penetrations shall be sealed to prevent water intrusion.
- 5. Welds shall be made a 4000 series for aluminum by persons qualified in accordance with AWG standards within the past two years.
- 6. This design is prototypical and should not be used for site specific applications unless deemed suitable by a competent Professional Engineer.



These documents represent prototypical design drawings created specifically for use by J.P. Morgan Chase. Use of this unpublished work for any purpose other than the intended application is strongly discouraged.

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 HT.
 BY:
 Project No.

 I
 TRR
 Ø8-1218

 F
 DATE:
 Drawing No.

 5
 2/4/II
 B244246

GRAPHICS DEPICTED ARE FOR ILLUSTRATIVE PURPOSES ONLY! USE ONLY APPROVED ARTWORK FOR PRODUCTION.

DESIGNATION: AWN-WU-M WINDOW

